Hearth House, Southampton, Appendices

Appendix 5. Site Plans

CONTENTS

PROPOSED VISUALS

PROPOSED PLANS

PROPOSED ELEVATIONS

BEFORE AND AFTER VISUALS

HULSE ROAD /FRONT ELEVATION _ PROPOSED




HULSE ROAD /ENTRANCE CORNER VIEW _ PROPOSED



HULSE ROAD /CORNER VIEW _ PROPOSED



GROUND FLOOR PLAN _ PROPOSED

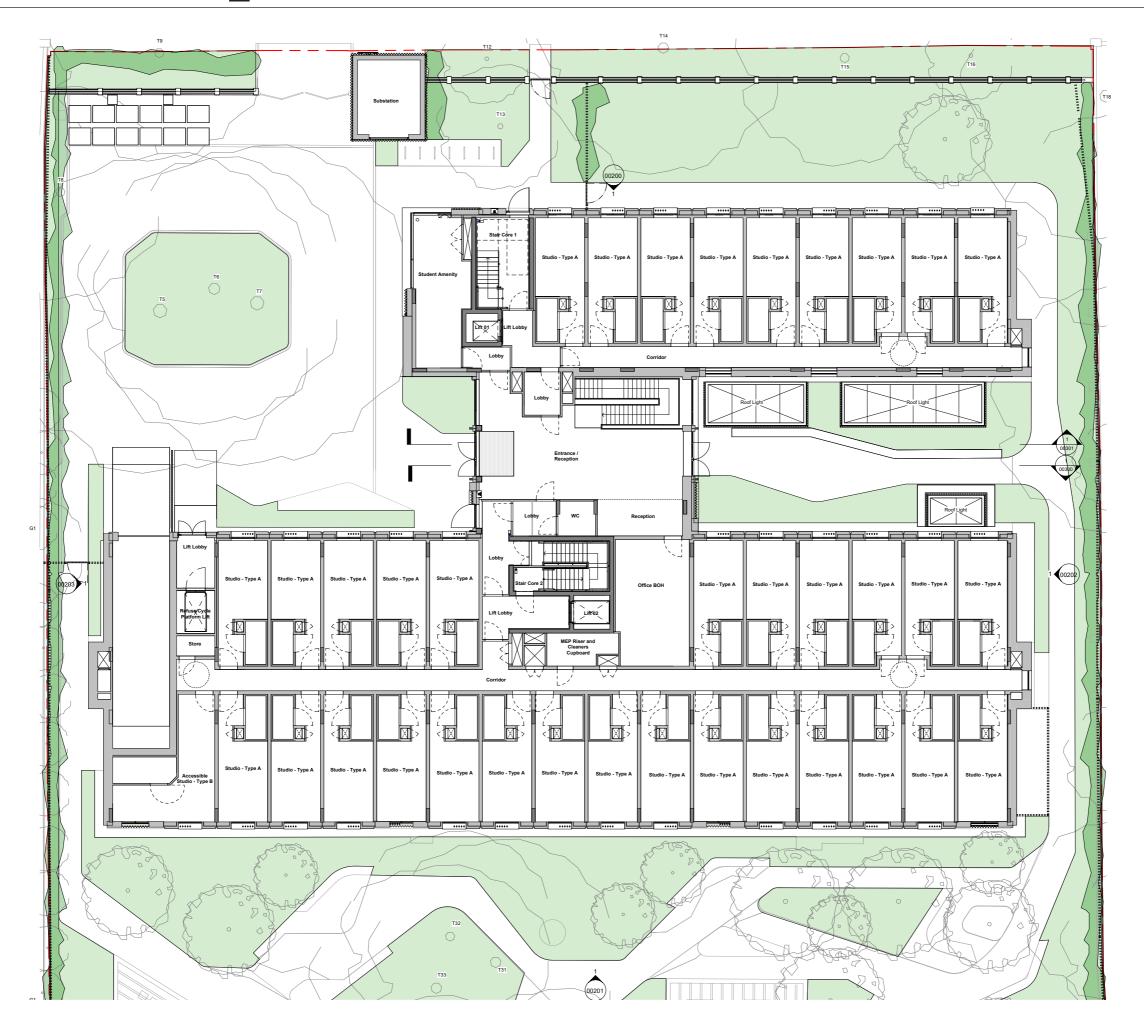


GROUND FLOOR PLAN _ PROPOSED

PROPOSED PLANTING CHANGED FOR PAVED BIN HOUSING AREA


MINOR CHANGE IN SIZE OF CORNER LOUNGE DUE TO DESIGN DEVELOP-MENT /COMPLIANCE

REVISED FACADE DUE TO HEAT LOSS /GAIN AT REAR CORNER


SMOKE SHAFT ADDED

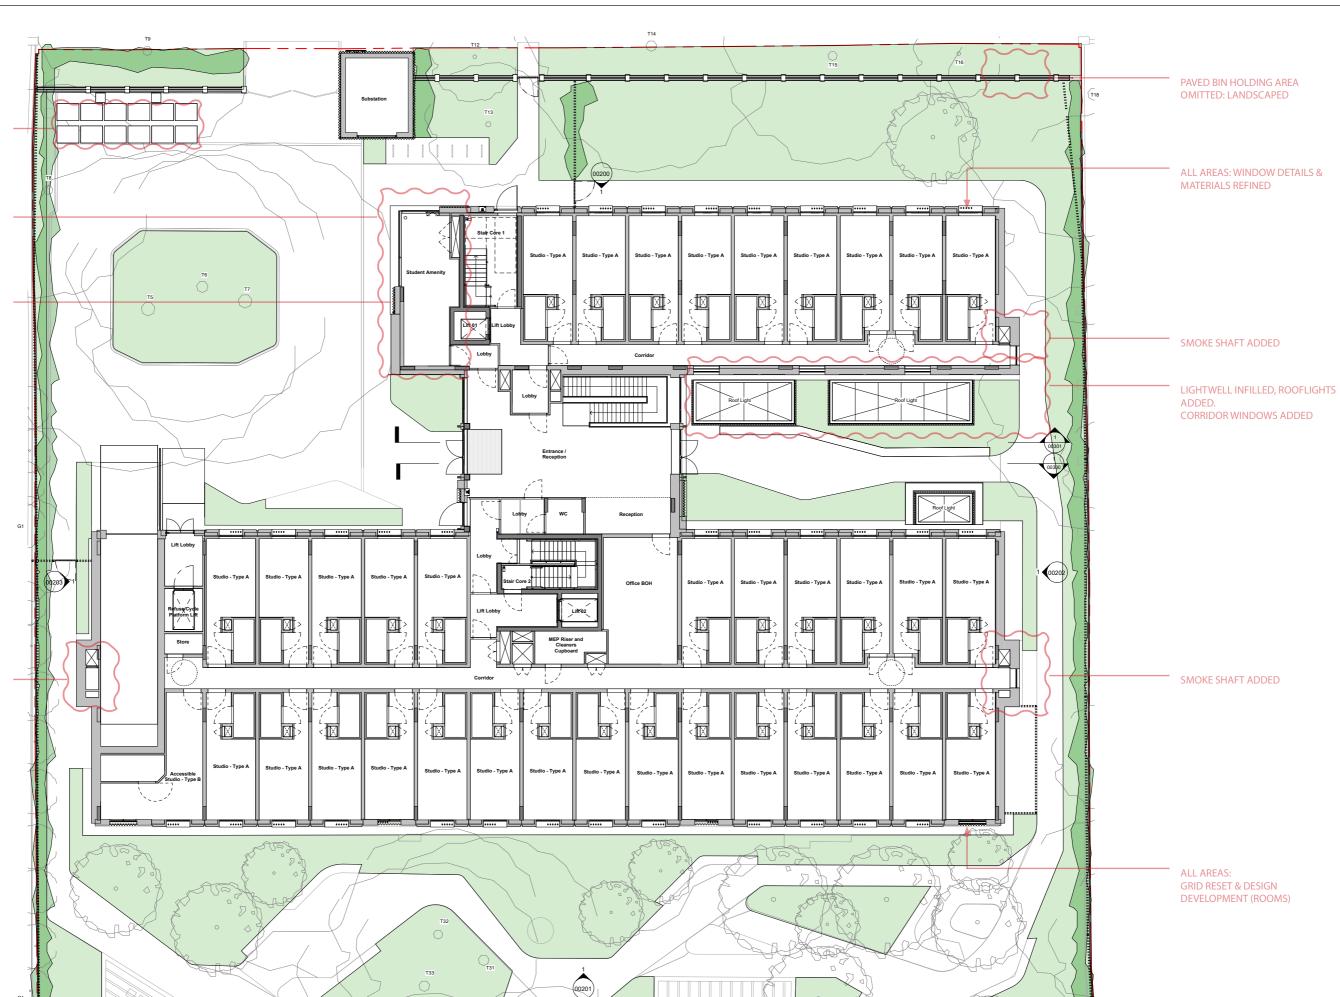


LEVEL 4 PLAN _ PROPOSED

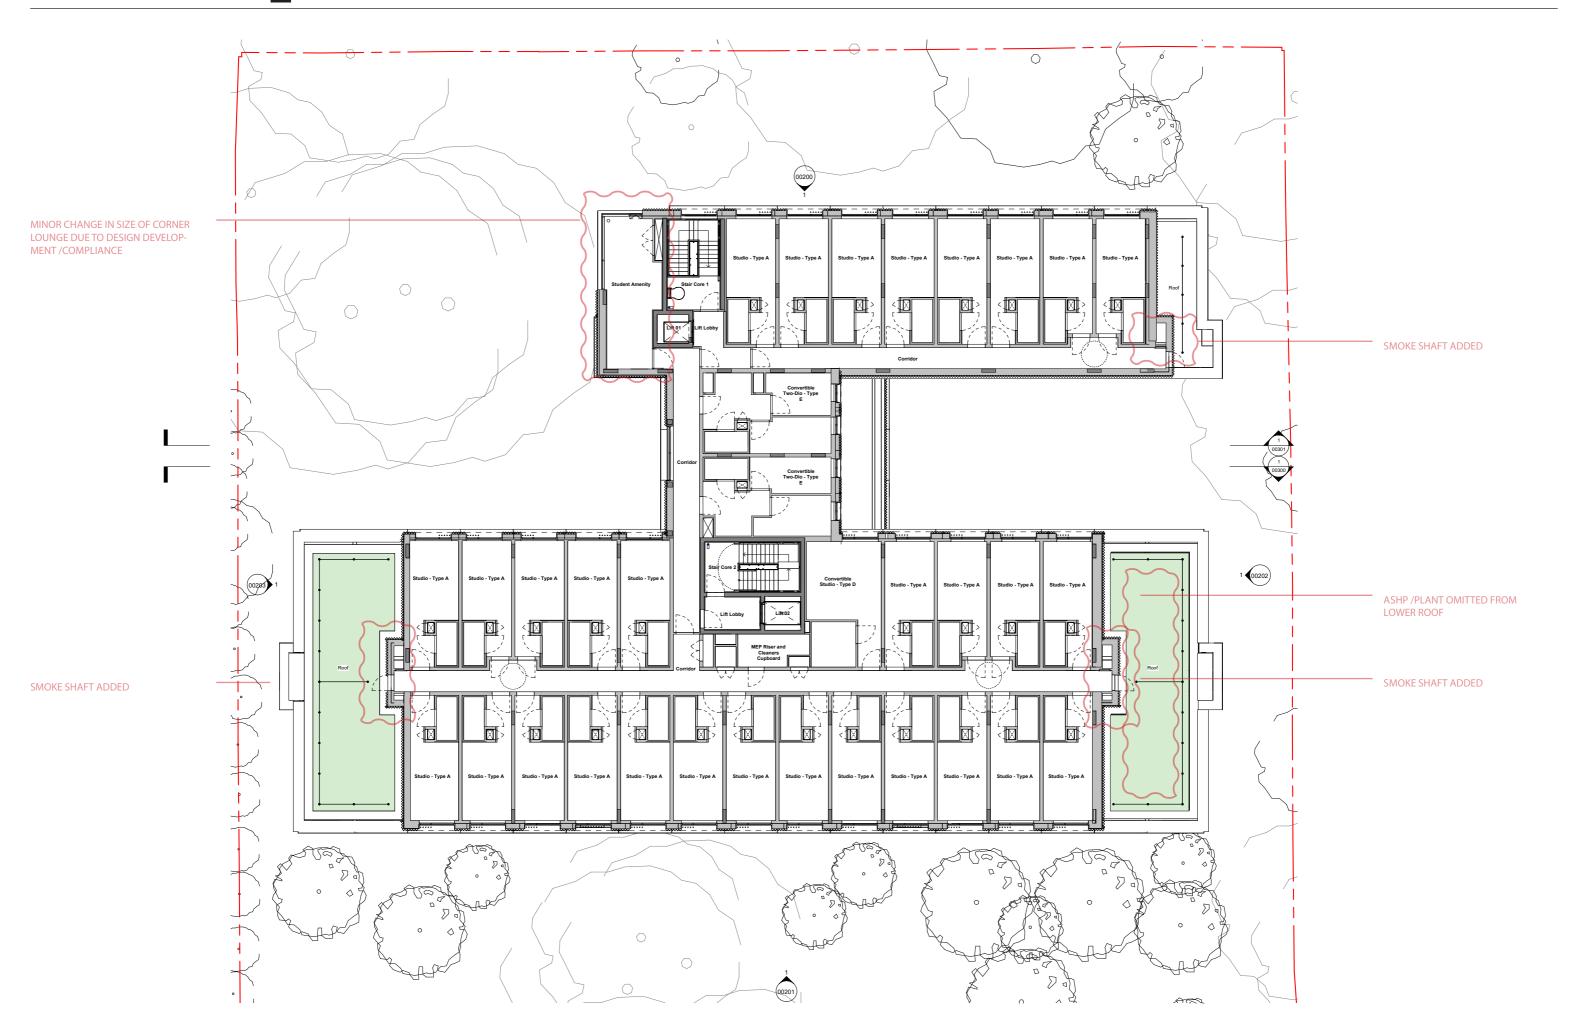

ROOF PLAN _ PROPOSED

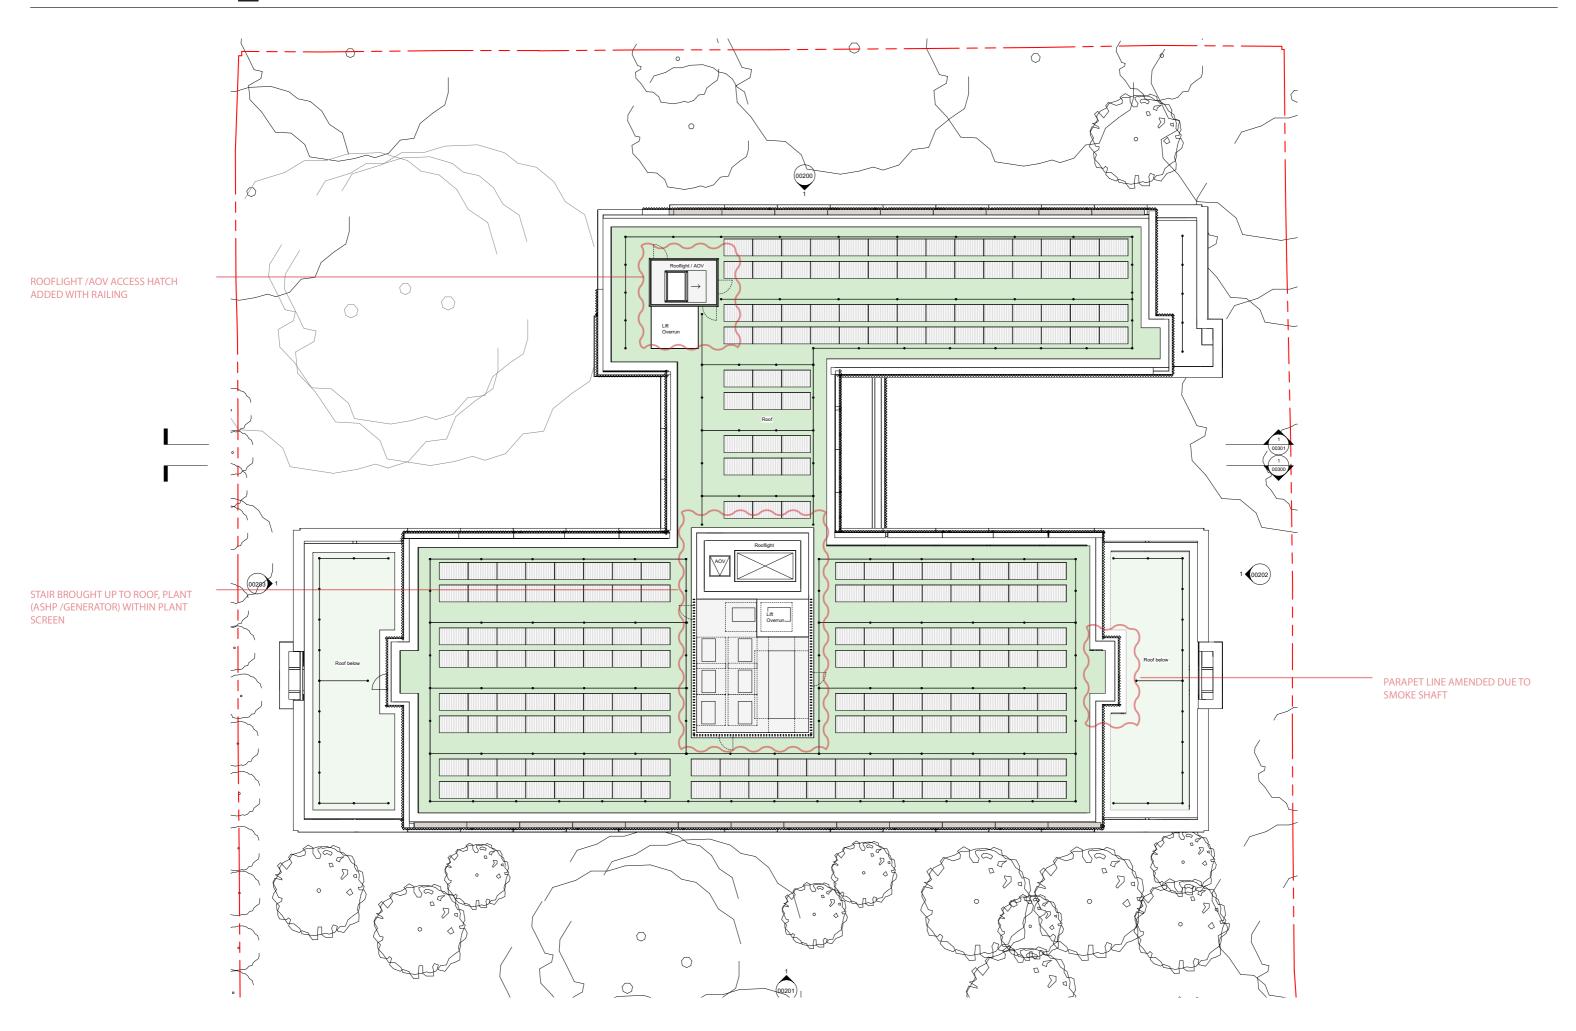

BASEMENT PLAN _ PROPOSED

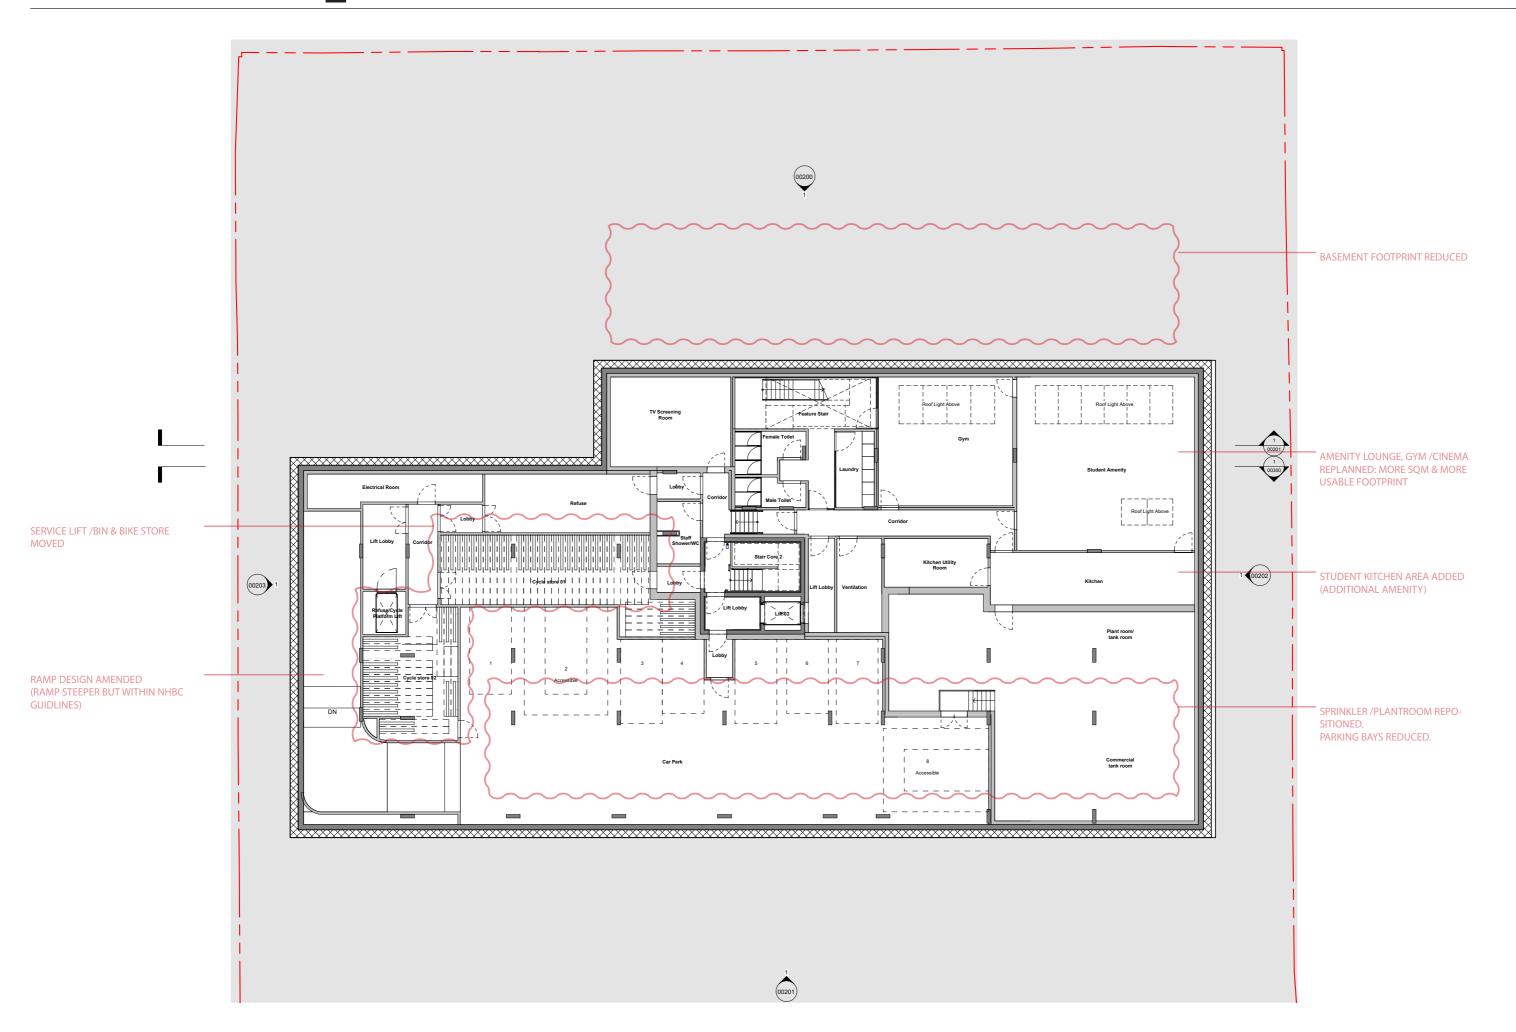

HULSE ROAD /FRONT ELEVATION _ PROPOSED



REAR ELEVATION _ PROPOSED



WEST ELEVATION _ PROPOSED



Materials Key

1 Terracotta Flat Tile

2 GRC Panel

 \neg

A Torrocotto Reguetto / Triangular pro

5 Existing-retained tree

8 Glazing - PPC Window Fran

Brickwork and string course pr

form 'frame' element of middle stor

.0 Air source heat pump

11 Terracotta Custom Triangular Pr

flank walls / facades

13 Metal Vehicle Gates, Motorised Matching Coloured Metalwork

EAST ELEVATION _ PROPOSED



COURTYARD ELEVATION 1 _ PROPOSED



COURTYARD ELEVATION 2 _ PROPOSED



laterials Key

1 Terracotta Flat Tile

2 GRC Panel

Ibstock Original Ivanhoe B

4 Terracotta Baquette/ Triangular profile

5 Existing-retained tree (approximate height show

6 Substation Over-clad in Terracotta

7 Perimeter fence in matching coloured metal

8 Glazing - PPC Window Fram

9 Brickwork and string course projection form 'frame' element of middle store'

10 Air source heat pur


11 Terracotta Custom Triangular Pro

12 Brick relief 'frame' patterning

13 Metal Vehicle Gates, Motorised. Matching Coloured Metalwork

FACADE BAY STUDY AND MATERIALS _ AT PLANNING



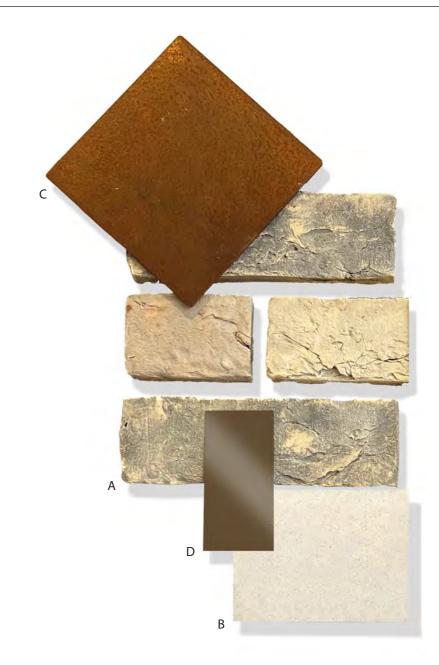













D. DARK BRONZE WINDOW FRAMES - RAL TBC

FACADE BAY STUDY AND MATERIALS _ PROPOSED



HULSE ROAD /FRONT ELEVATION _ PROPOSED



HULSE ROAD /CORNER VIEW _ PROPOSED



HULSE ROAD /ENTRANCE CORNER VIEW _ PROPOSED



WGP ARCHITECTS

27 Bulwer Street


London

W12 8AR


+44 (0)20 8735 5367


info@wgp-architects.com


wgp-architects.com

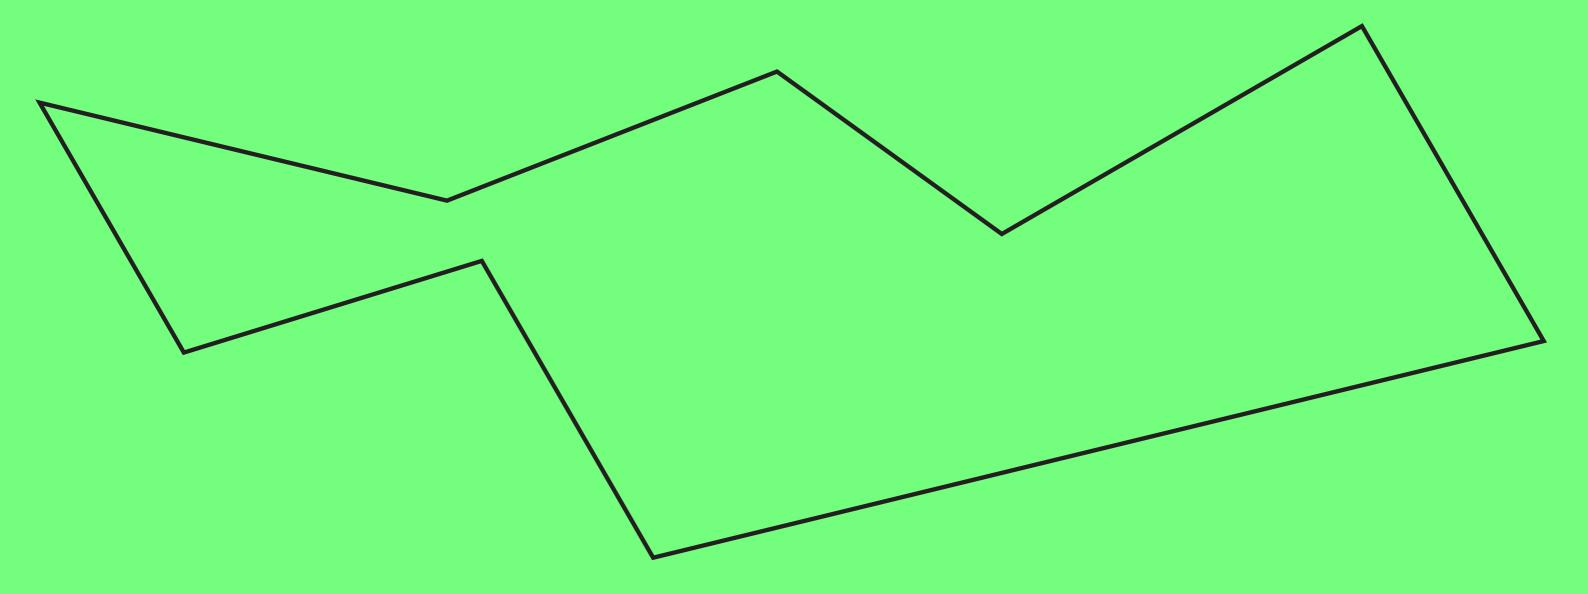

Appendix 6. Landscaping Plans

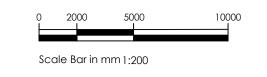

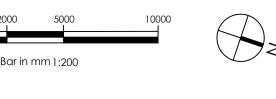

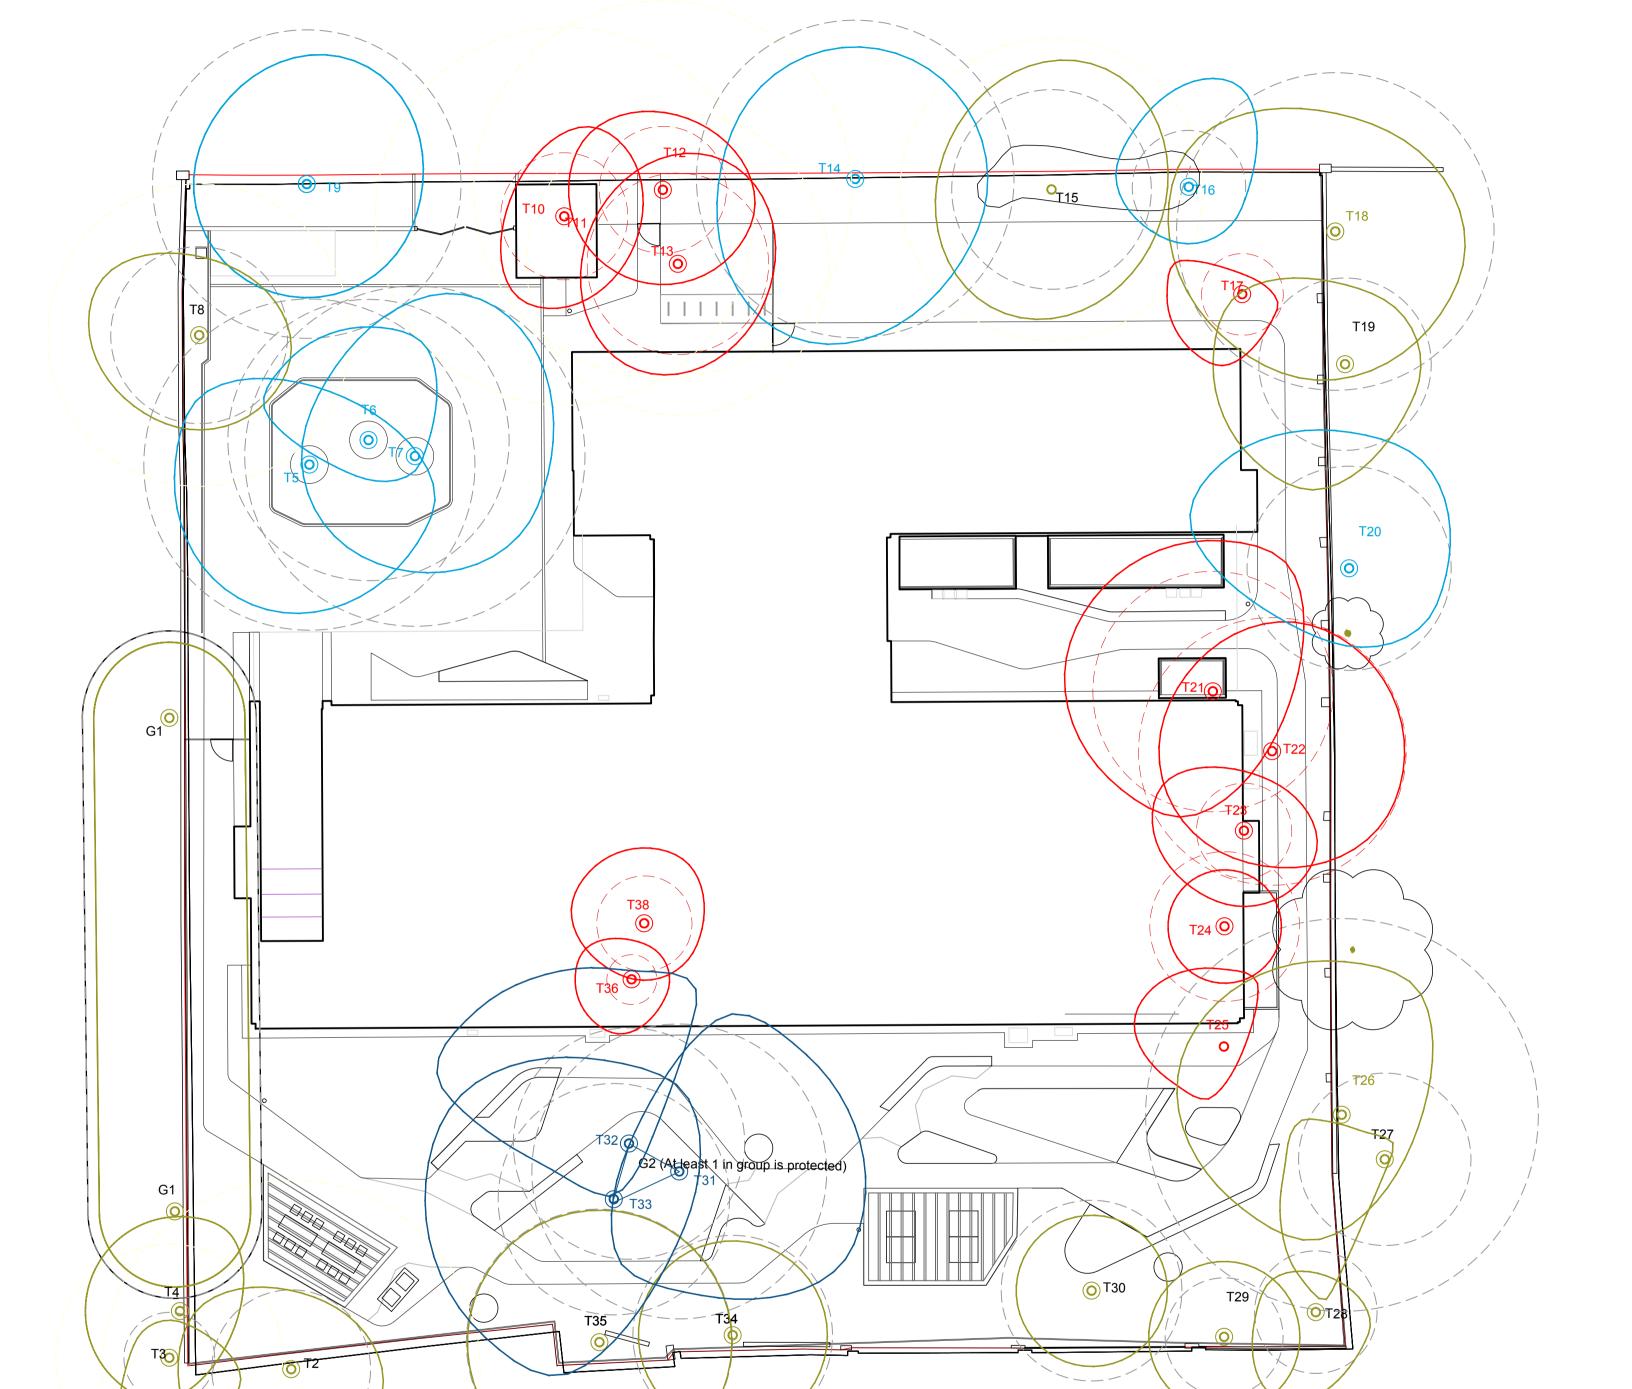

Site boundary

Existing TPO Tree Retained Existing Tree Retain (Potential TPO) Existing Tree Retain Existing Tree Remove Existing tree RPA

NOTES:

 This drawing is to be read in conjunction with all relevant contract documentation from the design team, with any conflicting information to be brought to the attention of Turkington Martin Landscape
Architects in writing before commencing on site.

2. The contractor is to check and verify all levels and dimensions before construction. Any discrepancies are to be brought to the attention of Turkington Martin Landscape Architects in writing before commencing on site.

3. All dimensions in mm, unless otherwise stated.

4. Do not scale from this drawing.

All sub base and concrete design and specification to engineer's details. All diagrams provided here are purely indicative.

6. Waterproofing of any element to be specified by

7. All proprietary products shall be installed in accordance with manufacturers written instructions.

8. Plant numbers are an indication only and plants should be ordered to suit site areas in accordance with scheduled plant densities.

Any proposed plant substitution shall be agreed with the landscape architect prior to ordering.

DATE DRAWN DESCRIPTION OF REVISION

turkington martin

Unit 2, Floor 2, Building C1, Design District, Soames Walk, London SE10 0BQ T: (+44) 020 3909 5979 E: studio@turkingtonmartin.com

CLIENT

PAPER SIZE :

Iconic Properties PROJECT TITLE

Hulse Road DRAWING TITLE

Tree Retention & Removal plan DRAWING STATUS

DRAWN DATE :

04.09.2023

CHECKED DATE: 04.09.2023


REVISION:


S3 Suitable for review & comment DRAWING SCALE: 1:200 AB

DRAWING NUMBER:

HR600-TM-ZZ-GF-DR-L-0500 P02

CHECKED BY:

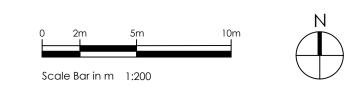

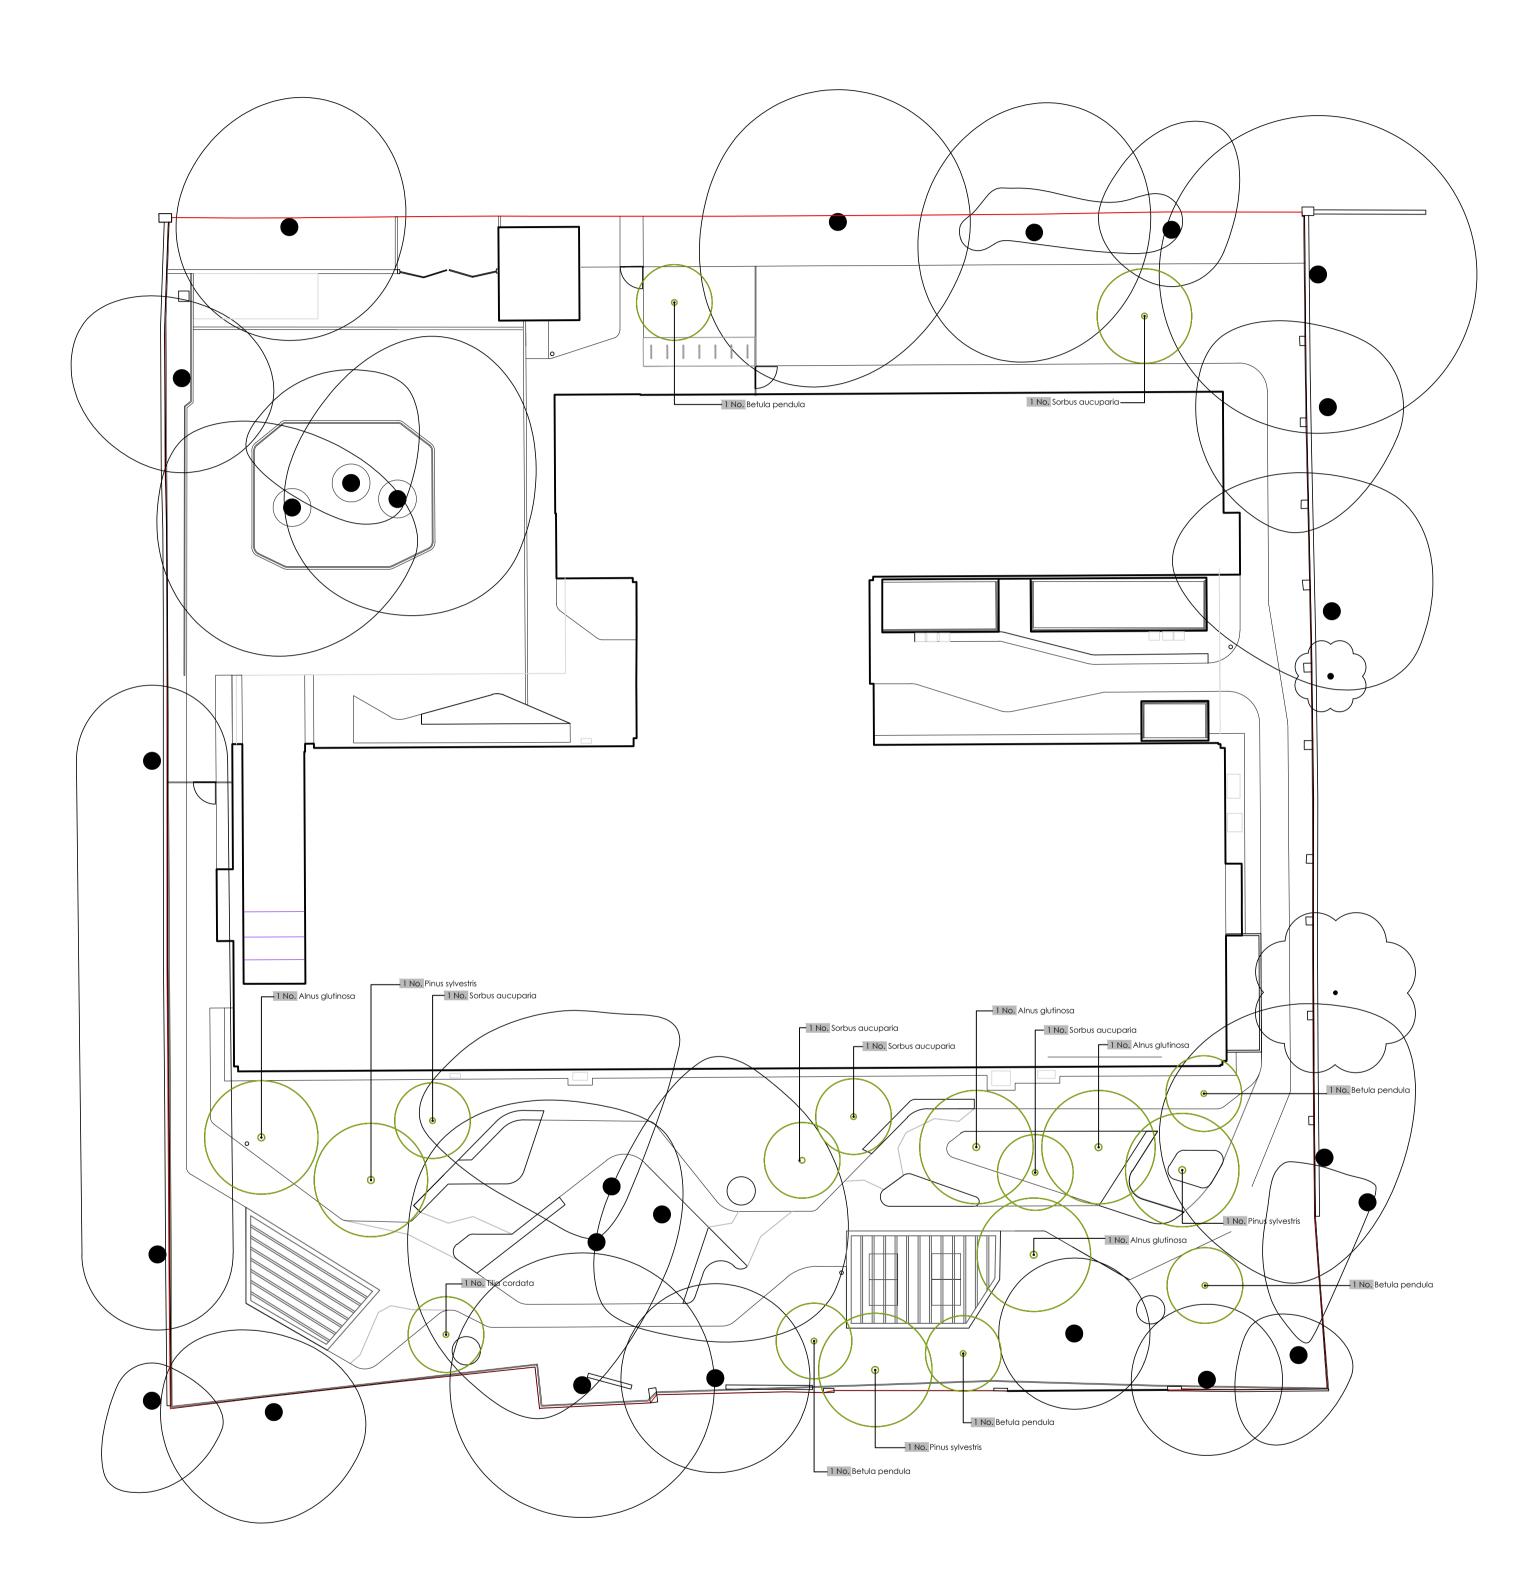

Hulse Road Tree Schedule

Number	Species	Height	Girth	Specification
4	Alnus glutinosa	5.0-6.0m	25-30cm	Clearstem min. 2m; Ø80cm/360kg root ball; healthy root system
5	Betula pendula	3.5-4.0m		Multistem; healthy root system
3	Pinus sylvestris	5.0-5.5m	20-25cm	Clearstem min. 2m; Ø70cm/250kg root ball; healthy root system
5	Sorbus aucuparia	4.5-5.5m		Multistem; healthy root system
1	Tilia cordata	4.5-5.5m	20-25cm	Clearstem min. 2m; Ø60cm/250kg root ball; healthy root system

NOTES:

This drawing is to be read in conjunction with all relevant contract documentation from the design team, with any conflicting information to be brought to the attention of Turkington Martin Landscape Architects in writing before commencing on site.

2. The contractor is to check and verify all levels and dimensions before construction. Any discrepancies are to be brought to the attention of Turkington Martin Landscape Architects in writing before commencing on site.

3. All dimensions in mm, unless otherwise stated.

4. Do not scale from this drawing.


All sub base and concrete design and specification to engineer's details. All diagrams provided here are purely indicative.

6. Waterproofing of any element to be specified by

7. All proprietary products shall be installed in accordance with manufacturers written instructions.

8. Plant numbers are an indication only and plants should be ordered to suit site areas in accordance with scheduled plant densities.

Any proposed plant substitution shall be agreed with the landscape architect prior to ordering.

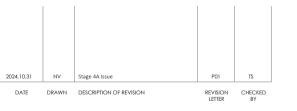

turkington martin

Unit 2, Floor 2, Building C1, Design District, Soames Walk, London SE10 0BQ T: (+44) 020 3909 5979 E: studio@turkingtonmartin.com

CLIENT

Iconic Properties
PROJECT TITLE

Hulse Road

DRAWING TITLE

Detailed Tree Plan 01

DRAWING STATUS
S3 Suitable for review & comment

 DRAWING SCALE:
 DRAWN BY:
 DRAWN DATE:


 1:100
 NV
 2024.10.31

 PAPER SIZE:
 CHECKED BY:
 CHECKED DATE:

 A1
 TS
 2024.10.31

DRAWING NUMBER : REVISION : HR600-TM-ZZ-GF-DR-L-0530 P01



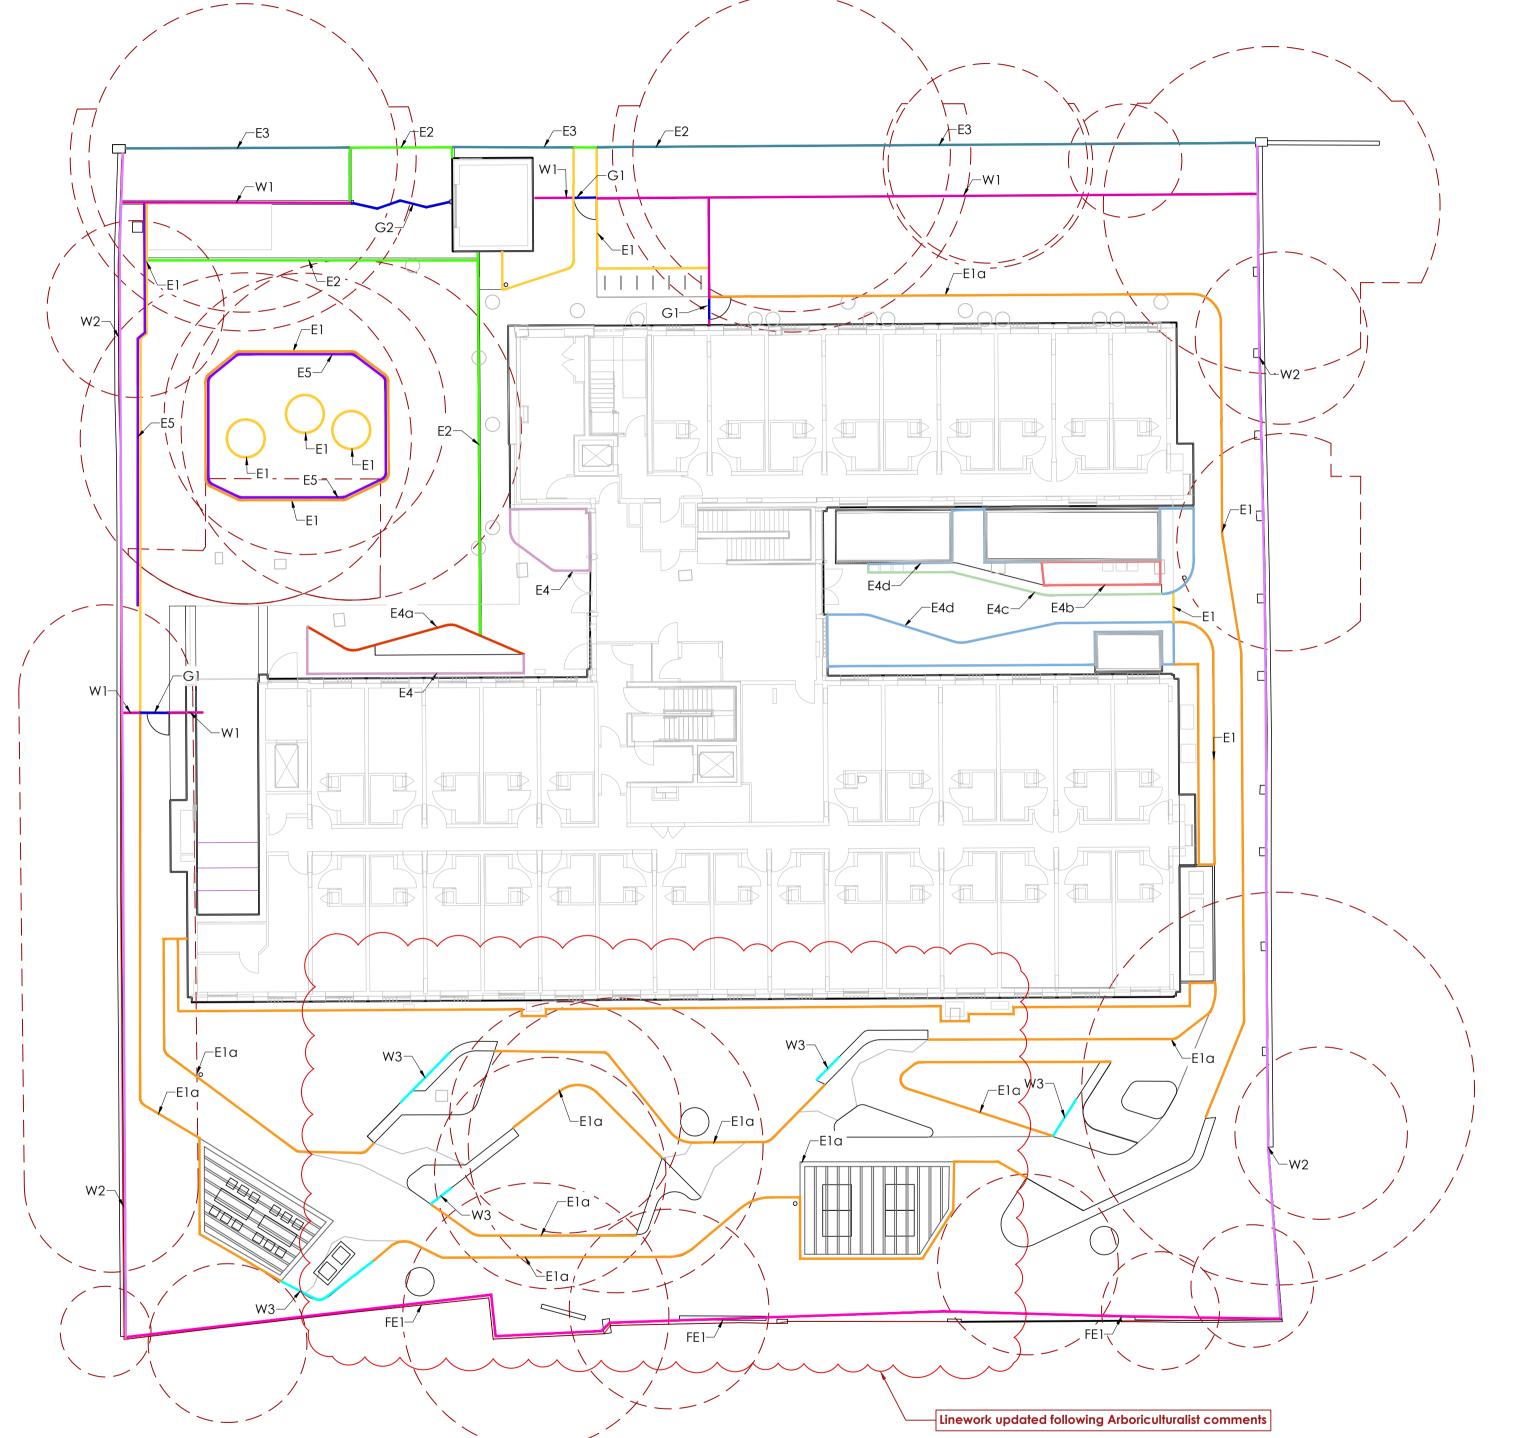

	Product Type	Product Reference	Manufacturer	Size	Material / Finish	Colour	Specification
E1	Flush metal edging	Bison, Galvanised	Kinley	3(W) x 150(H) mm	Galvanized steel	Silver	Bison 150mm internal / external corners, manufacturer's details
Ela	Raised metal edging	Urban, Galvanised	KInley	3(W) x 150(H) mm	Galvanized steel	Silver	Urban 100mm internal / external corners, manufacturer's details
E2	Dropped Concrete kerb	Textured Kerb	Tobermore	914(L) x 125(W) x 255(H) mm	Textured concrete	Natural	laid butt jointed, haunching and sub-base t engineer's details
E3	Existing Concrete kerb	Textured Kerb			Textured concrete	Natural	Made good where require
E4	Raised Planter To Entrance	Planterline curved	RAAFT	To meet 500mm above FFL	Corten steel	Weatherd Steel	3mm thick Grade A Weath Steel wall, Preformed pand continuous return to top e seamless joints, positioned corners, to include water r
E4a	Raised Planter With Vent	Planterline curved with bespoke lazer cur pannel	RAAFT	To meet 500mm above FFL	Corten steel	Weatherd Steel	3mm thick Grade A Weatl Steel wall, Preformed pan- continuous return to top e seamless joints, positioned corners, to include water r
E4b	Raised Planter on Concrete Duct Work	Planterline curved	RAAFT	To meet 700mm above FFL, to match MEP structural requirements	Corten steel	Weatherd Steel	3mm thick Grade A Weat Steel wall, Preformed pan- continuous return to top e seamless joints, positioned corners, to include water r
E4C	Raised Planter With Vent	Planterline curved with bespoke lazer cur pannel	RAAFT	To meet 700mm above FFL, to match MEP structural requirements	Corten steel	Weatherd Steel	3mm thick Grade A Weath Steel wall, Preformed pand continuous return to top e seamless joints, positioned corners, to include water r
E4d	Raised Planter To Entrance	Planterline curved	RAAFT	To meet 700mm above FFL	Corten steel	Weatherd Steel	3mm thick Grade A Weath Steel wall, Preformed pand continuous return to top es seamless joints, positioned corners, to include water r
E5	Knee Rail			400(H)mm	Timber		

	Product Type	Product Reference	Manufacturer	Size	Material / Finish	Colo
W1	Railing Fence To Entrance	Sienna	Lang and Fulton	1800(H) mm	galvanized and powder coated	matt mica grey
W2	Railing Topper to Existing Boundary	To match Sienna	Lang and Fulton	Approx 300 (H) Total 2100 (H) mm	galvanized and powder coated	matt mica grey
W3	Feature wall	Textured conc wall	Bespoke	Varies 750(H) 450(H) 250(H)mm	Concrete block wall with textured concrete render finish	Chalk
FE1	Timber Fence	Venetian Hit And Miss	Jackson Fencing	2100(H) mm	Treated FSC certified softwood fence panel, timber top rail Pre-cast concrete fence post & gravel board	Naturo
G1	Single Leaf Gate to Entrance	To match Sienna	Lang and Fulton	1800(H) mm 1200(W) mm	galvanized and powder coated	matt mica grey
G2	Bi-Fold Vehicular Gate to Entrance	To match Sienna	Lang and Fulton	1800(H) mm	galvanized and powder coated	matt mica grey

NOTES:

 This drawing is to be read in conjunction with all relevant contract documentation from the design team, with any conflicting information to be brought to the attention of Turkington Martin Landscape Architects in writing before commencing on site.

2. The contractor is to check and verify all levels and dimensions before construction. Any discrepancies are to be brought to the attention of Turkington Martin Landscape Architects in writing before commencing on site.

3. All dimensions in mm, unless otherwise stated.

4. Do not scale from this drawing.

5. All sub base and concrete design and specification to engineer's details. All diagrams provided here are purely indicative.

6. Waterproofing of any element to be specified by

7. All proprietary products shall be installed in accordance with manufacturers written instructions.

8. Plant numbers are an indication only and plants should be ordered to suit site areas in accordance with scheduled plant densities.

9. Any proposed plant substitution shall be agreed with the landscape architect prior to ordering.

DATE DRAWN DESCRIPTION OF REVISION

turkington martin

Unit 2, Floor 2, Building C1, Design District, Soames Walk, London SE10 0BQ T: (+44) 020 3909 5979 E: studio@turkingtonmartin.com

> CLIENT **Iconic Properties**

PROJECT TITLE Hulse Road

DRAWING TITLE Edges & Boundaries GA DRAWING STATUS

S3 Suitable for review & comment


DRAWING SCALE: 1:200 PAPER SIZE : CHECKED BY:

DRAWN DATE :


10.10.2023 CHECKED DATE: 10.10.2023

REVISION:

DRAWING NUMBER: HR600-TM-ZZ-GF-DR-L-0211 P04

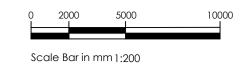



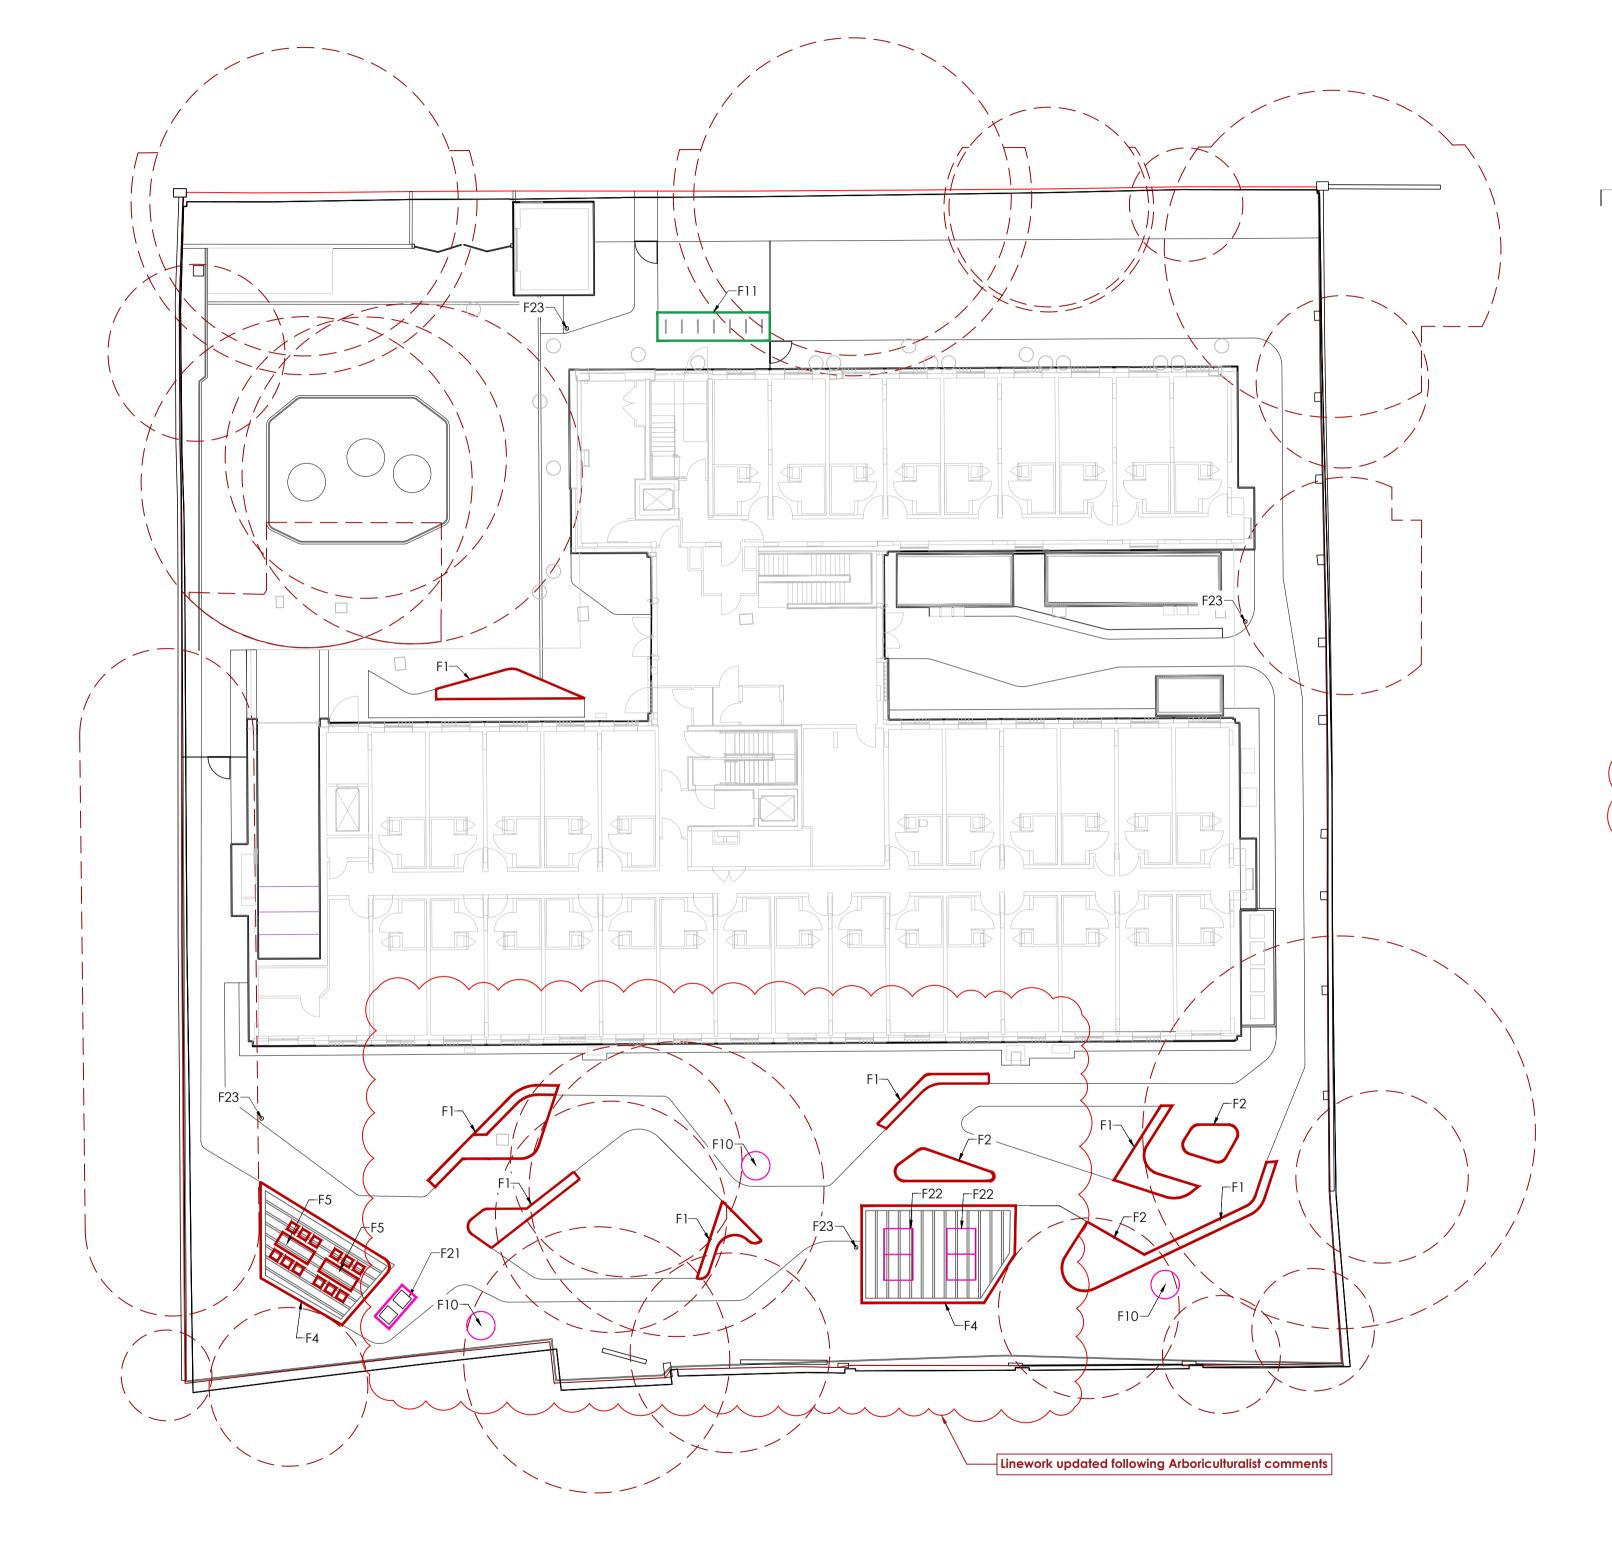

Furniture Schedule Manufacturer Size Colour **Specification** Product Type Product Material / Finish Reference Clifton FSC certified Root fixed to manufacturer's Timber bench to Woodscape communal hardwood top, min. recommendation. Allow for 65mm thick timber timber backrest to 10% of length slats x 150mm high, and armrest / 2m length, Galv. PPC Galvanised steel legs, Woodscape FSC certified Root fixed to manufacturer's Timber platform Bespoke recommendation. Allow for to communal Bench hardwood top, min. timber backrest to 10% of length 65mm thick timber slats x 150mm high, and armrest / 2m length, Galv. PPC Galvanised steel legs, Pergola to BBQ Bespoke Woodscape Bespoke European FSC oak, Posts and frame 150x150mm, battens 55x150mm - lap jointed Fabrication seasoned, planed Root fixed fixed using galvanised Refer to Materials steel stirrup post base GA to concrete foundation, to contractors design European FSC oak, Oak Woodscape Posts and frame 150x150mm, Pergola to Table Bespoke Bespoke battens 55x150mm - lap jointed seasoned, planed Fabrication Refer to Root fixed fixed using galvanised Furniture steel stirrup post base to concrete foundation, to contractors design European FSC oak, RAL TBC Picnic Bench Mill Picnic Woodscape 2000)(L) FSC® Naturally Very Durable Hardwood, Galvanised Steel, seasoned, planed Rowder-soated Steel (715(L) x Visitors cycle Stainless steel, root fixed to Cycle Stand 800(H)mm include tapping bar with Tapping Bar Terrace Varies Corten Steel Weathered Hammered copper birdbaths F20 Bird bath to formaion gardener steel with spout pouring lip communal 2200(W) x Corten Steel BBQ to ICON Series Timberplay Weathered 1000(D) x communal Large /Christie 860(H) mm garden All-access powder Barbecue coat Mix of White 1525(W) x

Corten steel feet &

polished dyed

concrete with aggregates

/ Grey / Buff

/ Tan

Table Tennis to

communal

Conc &

steel table

Bespoke

2740(L) x

760(H) mm

NOTES:

1. This drawing is to be read in conjunction with all relevant contract documentation from the design team, with any conflicting information to be brought to the attention of Turkington Martin Landscape Architects in writing before commencing on site.

2. The contractor is to check and verify all levels and dimensions before construction. Any discrepancies are to be brought to the attention of Turkington Martin Landscape Architects in writing before commencing on site.

3. All dimensions in mm, unless otherwise stated.

4. Do not scale from this drawing.

5. All sub base and concrete design and specification to engineer's details. All diagrams provided here are purely indicative.

6. Waterproofing of any element to be specified by

7. All proprietary products shall be installed in accordance with manufacturers written instructions.

8. Plant numbers are an indication only and plants should be ordered to suit site areas in accordance with scheduled plant densities.

9. Any proposed plant substitution shall be agreed with the landscape architect prior to ordering.

Alternate product TBC

DATE DRAWN DESCRIPTION OF REVISION

DRAWN DATE :

10.10.2023

CHECKED DATE : 10.10.2023

REVISION:

turkington martin

Unit 2, Floor 2, Building C1, Design District, Soames Walk, London SE10 0BQ T: (+44) 020 3909 5979 E: studio@turkingtonmartin.com

CLIENT

Iconic Properties PROJECT TITLE


Hulse Road DRAWING TITLE


Furniture GA DRAWING STATUS

S3 Suitable for review & comment

DRAWING SCALE: 1:200 AB PAPER SIZE : CHECKED BY:

DRAWING NUMBER: HR600-TM-ZZ-GF-DR-L-0212 P04

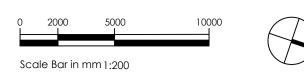

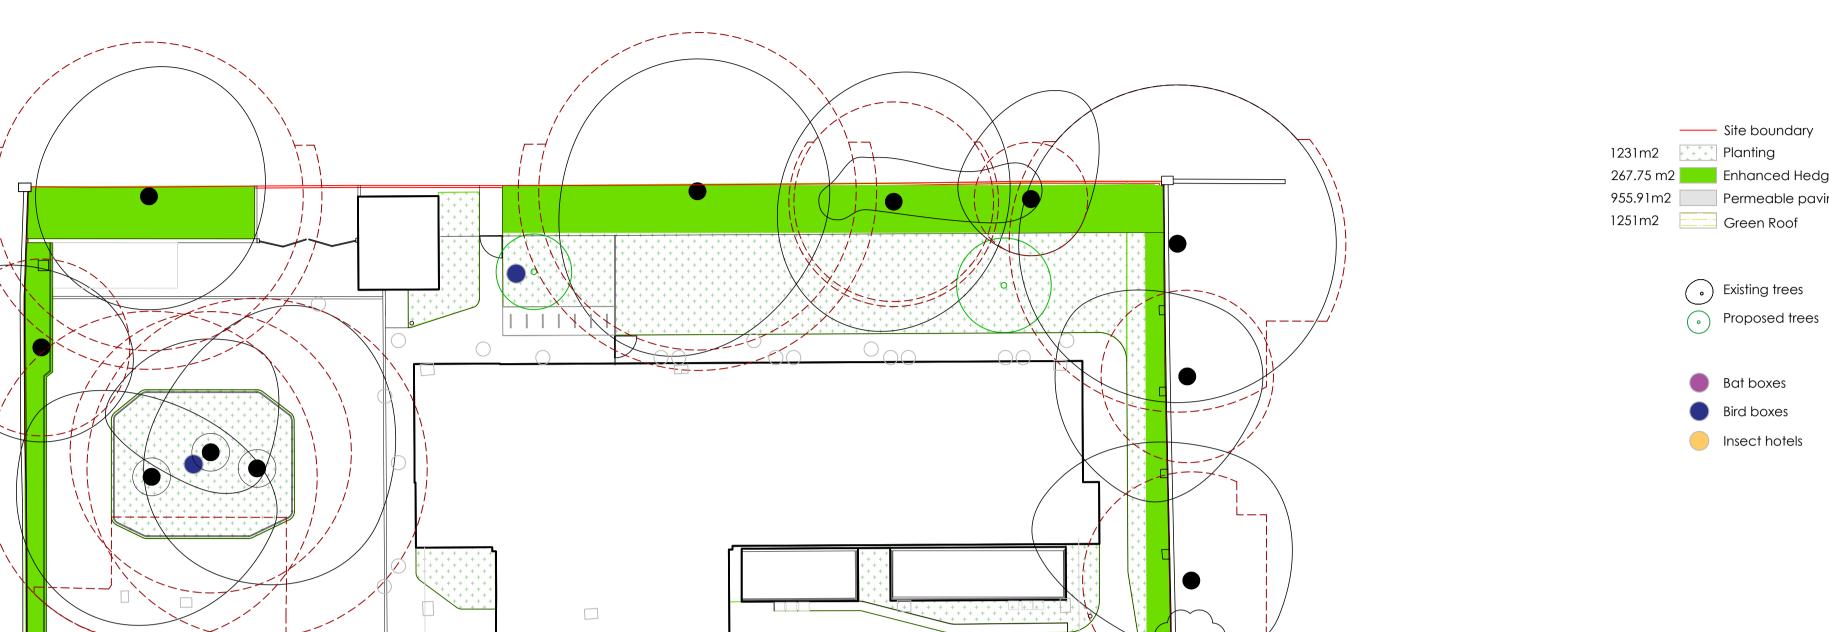

Site boundary 267.75 m2 Enhanced Hedgerow 955.91m2 Permeable paving

Existing trees

NOTES:

 This drawing is to be read in conjunction with all relevant contract documentation from the design team, with any conflicting information to be brought to the attention of Turkington Martin Landscape
Architects in writing before commencing on site.

2. The contractor is to check and verify all levels and dimensions before construction. Any discrepancies are to be brought to the attention of Turkington Martin Landscape Architects in writing before commencing on site.

3. All dimensions in mm, unless otherwise stated.

4. Do not scale from this drawing.

5. All sub base and concrete design and specification to engineer's details. All diagrams provided here are purely indicative.

6. Waterproofing of any element to be specified by

7. All proprietary products shall be installed in accordance with manufacturers written instructions.

8. Plant numbers are an indication only and plants should be ordered to suit site areas in accordance with scheduled plant densities.

Any proposed plant substitution shall be agreed with the landscape architect prior to ordering.



turkington martin

Unit 2, Floor 2, Building C1, Design District, Soames Walk, London SE10 0BQ T: (+44) 020 3909 5979 E: studio@turkingtonmartin.com

CLIENT

Iconic Properties PROJECT TITLE

Hulse Road DRAWING TITLE

Habitat plan DRAWING STATUS S3 Suitable for review & comment

DRAWING SCALE: 1:200 AB PAPER SIZE : CHECKED BY:


DRAWN DATE :

04.09.2023


CHECKED DATE: 04.09.2023

REVISION:

DRAWING NUMBER: HR600-TM-ZZ-GF-DR-L-0520 P04

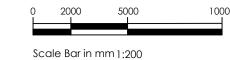



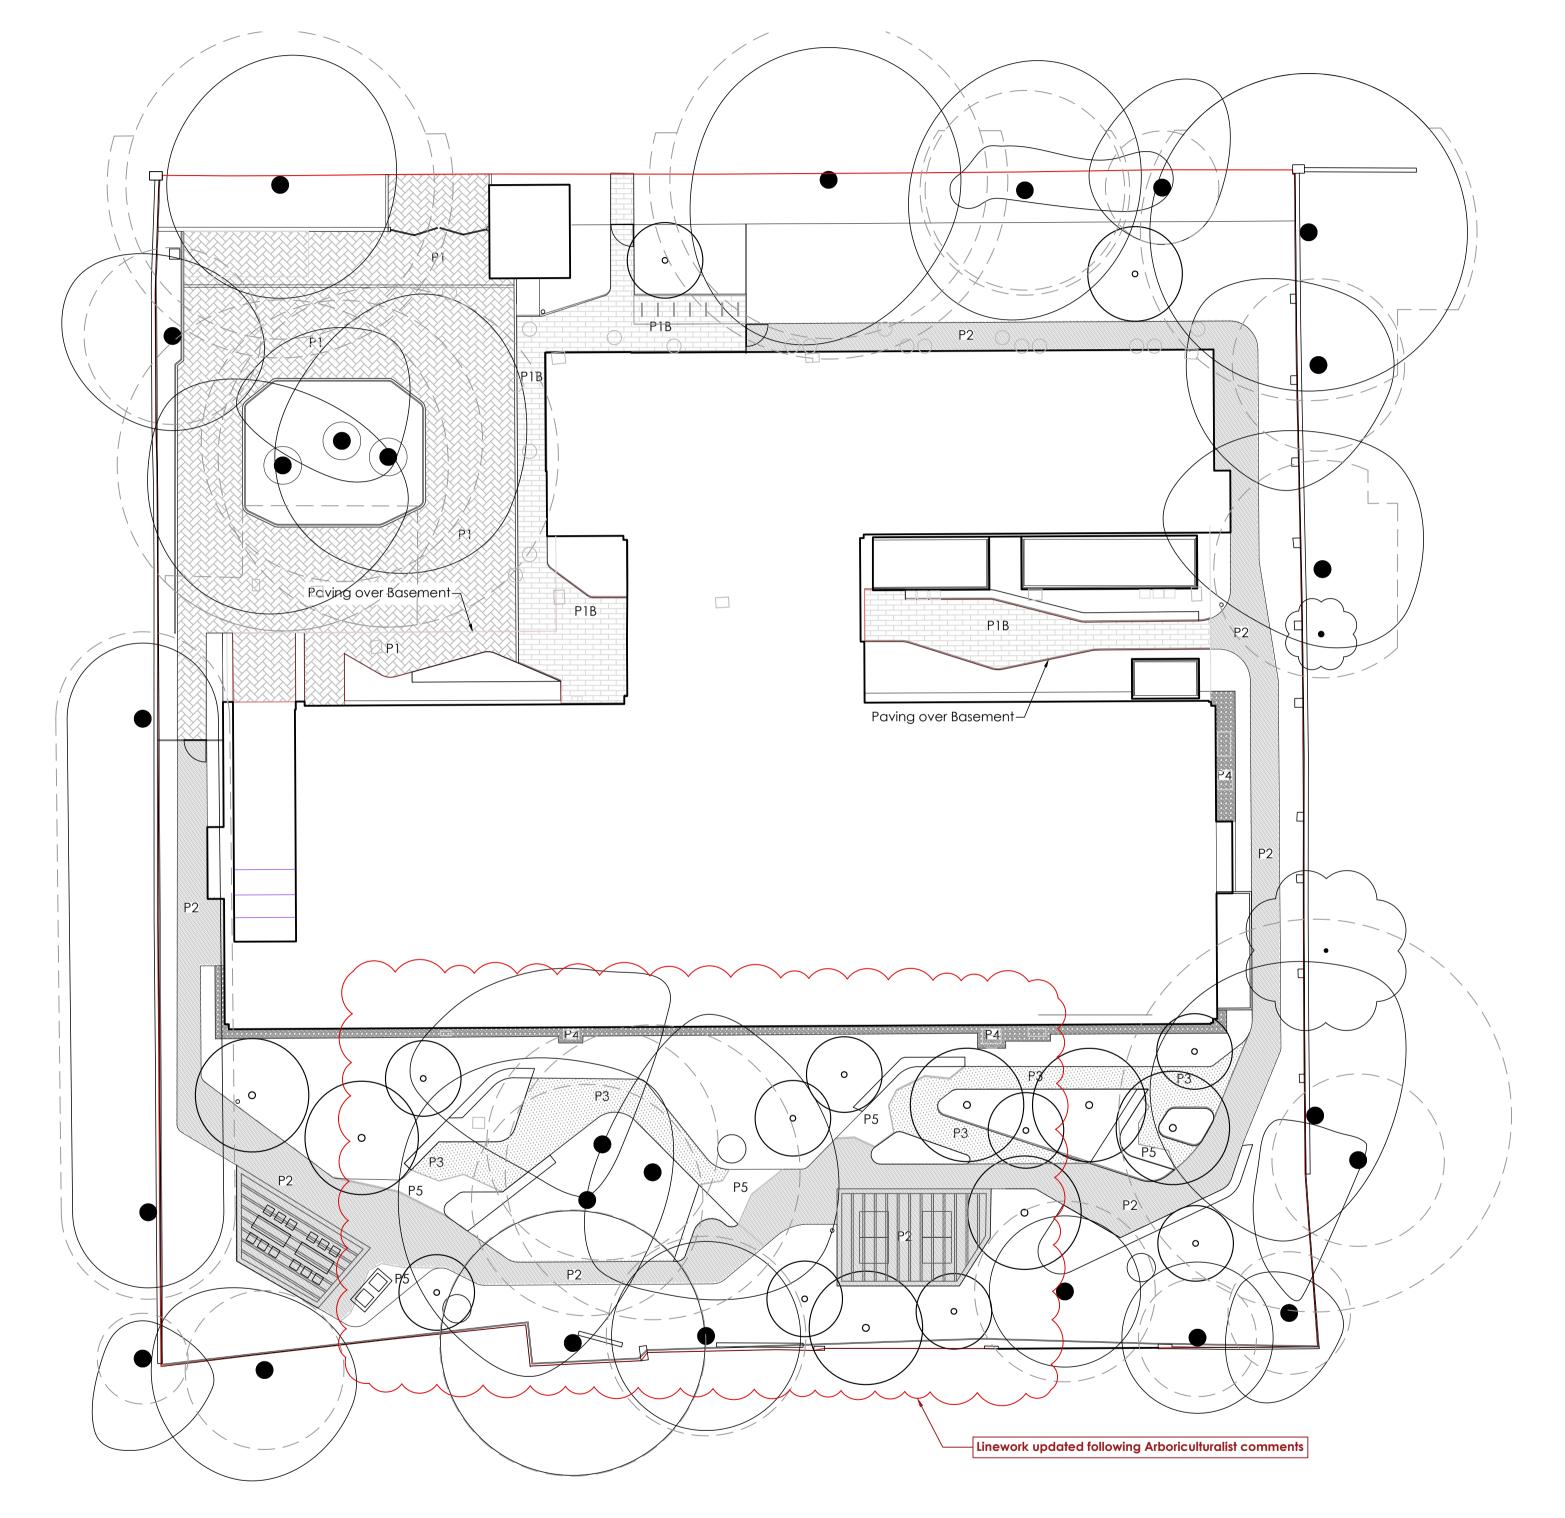

Surfacing Schedule

	Product Type	Product Reference	Manufacturer	Size	Material / Finish	Colour	Specification
P1	Concrete Block Paving To Entrance	Modal X Priora	Marshalls	200(L) x 100(W) x 80(T) mm	Granite Textured	60% silver grey, 25% Indian Granite, 15% Oatmeal	Herringbone bond, 90° Permeable Subbase to engineers spec.
P1B	Concrete Block Paving To Entrance	Modal X Priora	Marshalls	600(L)x200(L)/ 300(L)x200(W)/ 200(L)x200(W)/ 80mm(D)	Granite Textured	Light Granit	Stretcher bond Permeable Subbase to engineers spec.
P2	Resinbound To Communal Garden	Terrabase Classic	Addagrip	Max 50(T)mm	Resin bond surfacing	Rustic Harvest	Resin bound: 6-10mm Terrabase Rustic aggregate: 5mm Terrabase Addagrid: 7.1mm by Addagrip approved installers. Terrabase Geofabric: 2.4mm by Addagrip approved installers.
P3	Resinbound To Communal Garden	Terrabase Classic	Addagrip	Max 50(T)mm	Resin bond surfacing	Rustic Iceberg	Resin bound: 6-10mm Terrabase Rustic aggregate: 5mm Terrabase Addagrid: 7.1mm by Addagrip approved installers. Terrabase Geofabric: 2.4mm by Addagrip approved installers.
P4	Decorative Gravel Margin	Barley Quartzite Aggregate	CED Ltd Stone	20 (T)mm	Gravel	Brown & Corn- yellow	10-20mm aggregrate size, 100mm thick, laid on geotextile membrane
P5	Bespoke paving Details To Communal Garden	Etched/ Imprinted concrete paving	Bespoke / Blyko	Varies	Concrete	Grey / Buff / Tan	Thickness to suppliers recommendations, subbase to engineers spec.

NOTES:

 This drawing is to be read in conjunction with all relevant contract documentation from the design team, with any conflicting information to be brought to the attention of Turkington Martin Landscape
Architects in writing before commencing on site.

2. The contractor is to check and verify all levels and dimensions before construction. Any discrepancies are to be brought to the attention of Turkington Martin Landscape Architects in writing before commencing on site.

3. All dimensions in mm, unless otherwise stated.

4. Do not scale from this drawing.

5. All sub base and concrete design and specification to engineer's details. All diagrams provided here are purely indicative.

6. Waterproofing of any element to be specified by

7. All proprietary products shall be installed in accordance with manufacturers written instructions.

8. Plant numbers are an indication only and plants should be ordered to suit site areas in accordance with scheduled plant densities.

Any proposed plant substitution shall be agreed with the landscape architect prior to ordering.

DATE DRAWN DESCRIPTION OF REVISION

turkington martin

Unit 2, Floor 2, Building C1, Design District, Soames Walk, London SE10 0BQ T: (+44) 020 3909 5979 E: studio@turkingtonmartin.com

CLIENT Iconic Properties

PROJECT TITLE

Hulse Road DRAWING TITLE

Surfacing GA DRAWING STATUS S3 Suitable for review & comment

DRAWING SCALE: 1:200 AB PAPER SIZE : CHECKED BY:


DRAWING NUMBER:


REVISION: HR600-TM-ZZ-GF-DR-L-0210 P04

DRAWN DATE :

10.10.2023

CHECKED DATE: 10.10.2023

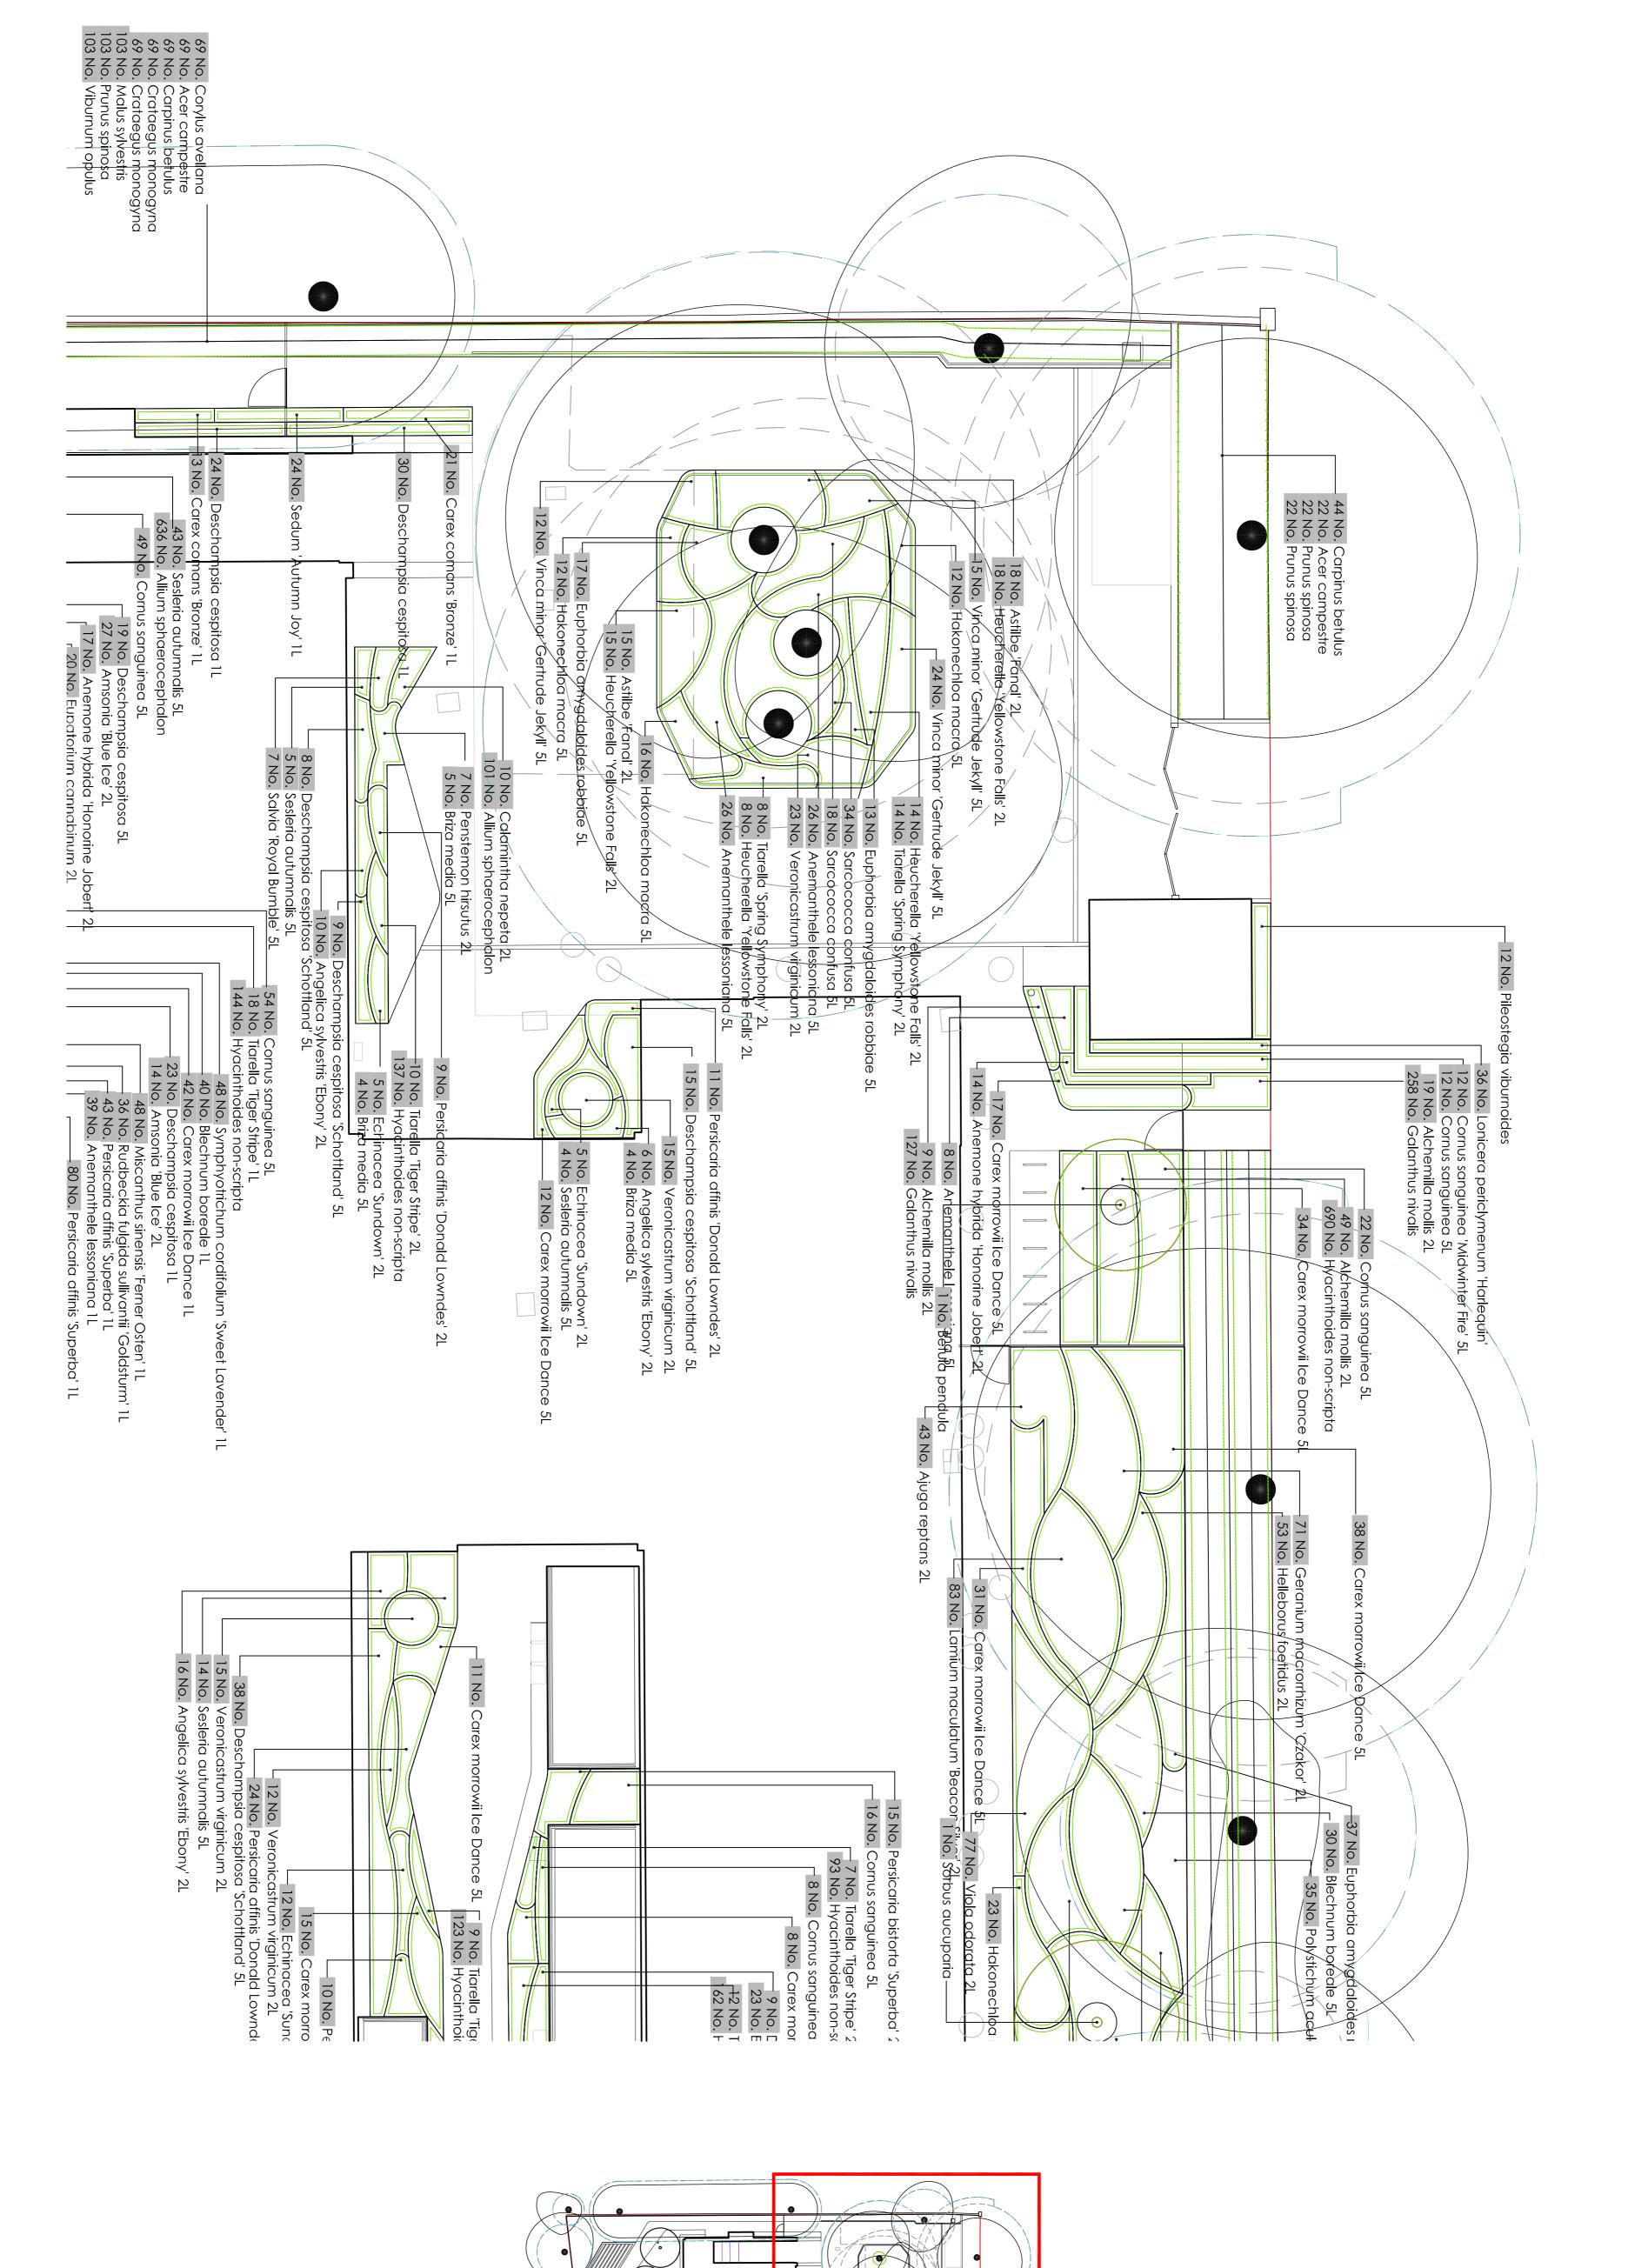

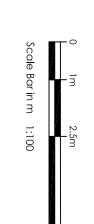




1. This drawing is to be read in conjunction with all relevant contract documentation from the design team, with any conflicting information to be brought to the attention of Turkington Martin Landscape Architects in writing before commencing on site.

The contractor is to check and verify all levels and mensions before construction. Any discrepancies to be brought to the attention of Turkington artin Landscape Architects in writing before symmencing on site.

4. Do not scale from this dra

Any proposed plant substitution shall be agreed ith the landscape architect prior to ordering. All sub base and concrete design and specification engineer's details. All diagrams provided here are urely indicative. Plant numbers are an indication only and plants ould be ordered to suit site areas in accordance th scheduled plant densities. All proprietary products shall be installed in cordance with manufacturers written instru

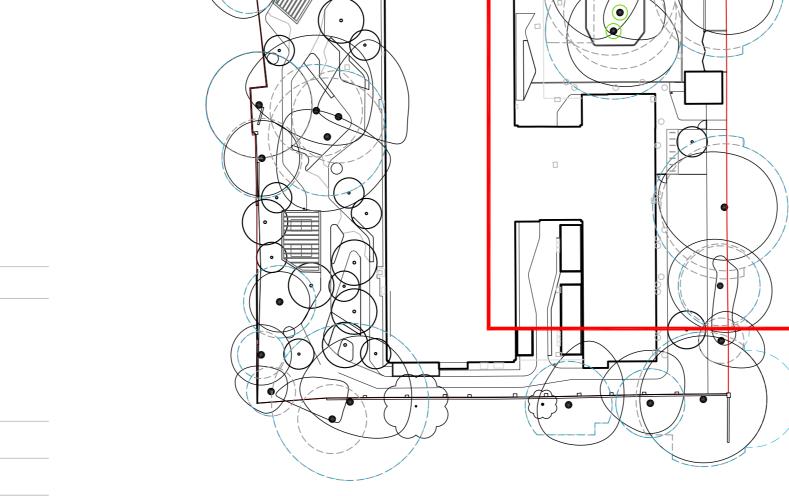

DATE	2024.10.31	
DRAWN	N	
DESCRPTION OF REVISION	Stage 4A issue	
REVISION	POI	
유		

turkington martin

Unit 2, Floor 2, Building C1, Design Dist Soames Walk, London SE10 0BQ T: (+44) 020 3909 5979 E: studio@turkingtonmartin.com

nic Propo

PROJECT TITLE Hulse Road Detailed Planting Plan 01 DRAWING STATUS & cor

DRAWN DATE:
2024.10.31
CHECKED DATE:
2024.10.31

1:100 PAPER SIZE

DRAWING NUMBER : HR600-TM-ZZ-GF-DR-L-0511 P01

Appendix 7. Building CGI's





